


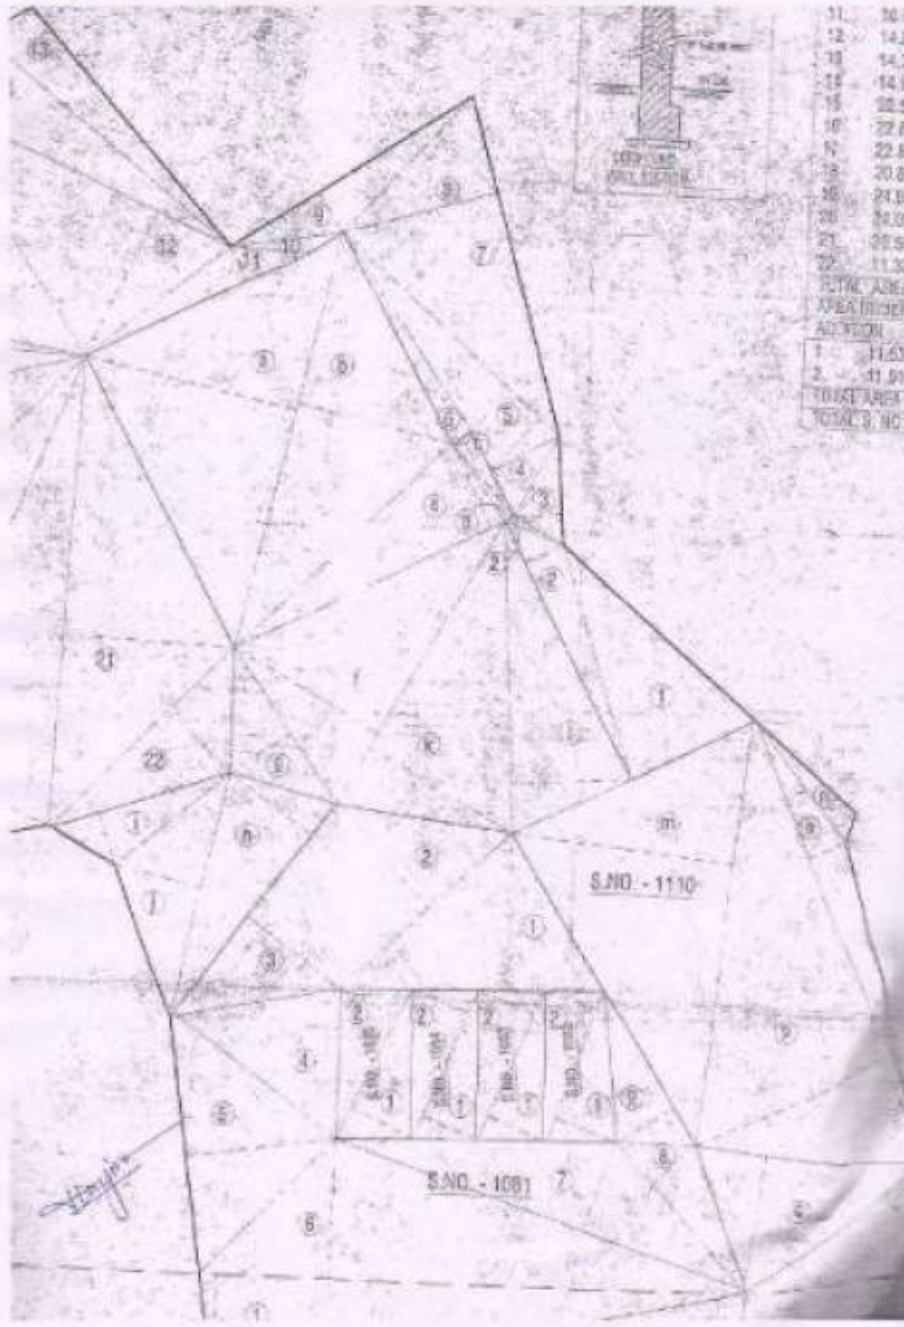

11	16.8
12	14.2
13	14.3
14	14.8
15	22.5
16	22.8
17	20.8
18	24.0
19	14.2
20	14.2
21	22.5
22	11.32


TOTAL AREA	
AREA UNDER	
ADDITION	
1	11.53
2	11.91
TOTAL AREA	
TOTAL NO.	





11	16.8
12	14.2
13	14.3
14	14.8
15	22.5
16	22.8
17	20.8
18	24.0
19	14.2
20	14.2
21	22.5
22	11.32

TOTAL AREA	
AREA UNDER	
ADDITION	
1	11.53
2	11.91
TOTAL AREA	
TOTAL NO.	

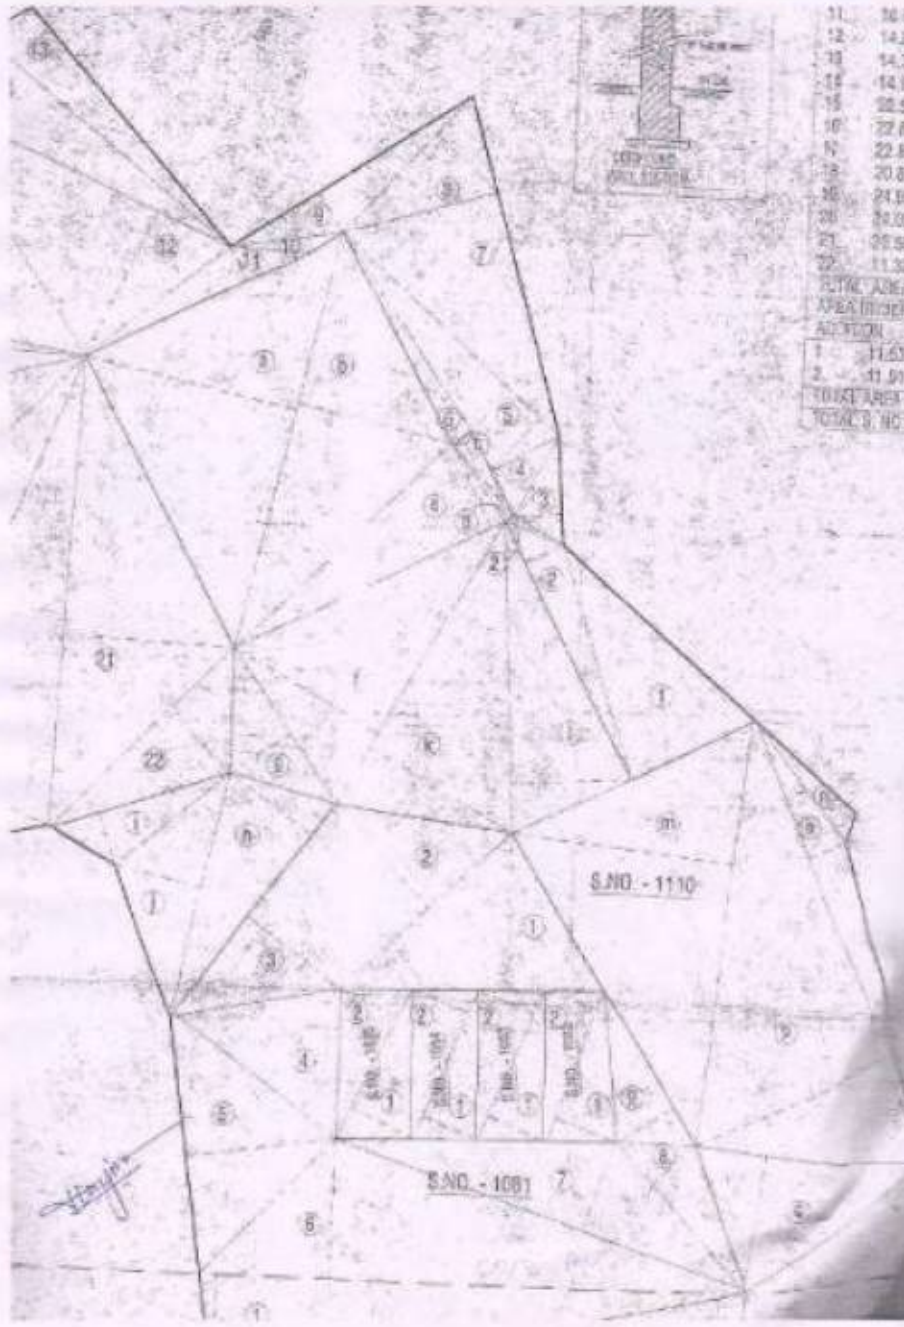

18 NOS  
20 NOS  
24 NOS  
30 NOS

### CERTIFICATE OF AREA

CERTIFIED THAT I HAVE SURVEYED THE PLOT UNDER REFERENCE ON AND THAT THE DIMENSIONS SHOWN ON THE PLAN ARE AS SHOWN ON SITE AND THE AREA SO WORKED OUT IS SUBJECT TO ANY AMENDMENTS BY THE RELEVANT AUTHORITIES AND THE DOCUMENT OF OWNERSHIP TO THE PLANNING SCHEME RECORDS.

ARCHITECT'S SIGNATURE

### DESCRIPTION

PROPOSED BUILDING ON PLOT BEHIND TIRA NO. 145, 147, 149, 151, 153, 155, 157, 159, 161, 163, 165 AT VILLAGE KALWA TAL. DIST. THANE.

### NAME & SIGNATURE OF OWNERS/IO/ALI

FOR

M/S. PARVATI CONSTRUCTION COMPANY FOR  
MR. SHANTILAL DAYARAM THAKKAR

### ARCHITECT



Architect & Interior Designer  
Santosh P. Chitambar  
10/1, 7th Floor, 10th North Apt,  
10th Cross, 2nd Stage, 1st Main,  
V. K. Laxmi Park, Phase 1, Chhatrapati Shivaji  
Maidan, Worli, Mumbai - 400 025.  
Ph: 2219 207 M, 7742 90510



SCALE	DRAWN BY	CHECKED
DATE	BY	DATE
PROJECT		
DATE		




2700 PM PAVING PLAN  
 SINGLE PARKING SPACES IN OPEN SPACE - 30 SPACES  
 TOTAL SCOOTER PARKING SPACES + 01 - 24 SPACES  
 TOTAL SCOOTER PARKING PROPOSED = 30 SPACES

*Handwritten signature*

1 TENEMENT / SCOOTER PARKING SPACE FOR EACH	10 NOS.	10
<b>DESCRIPTION (COMMERCIAL)</b>		
1 PARKING SPACE FOR EVERY 25 SQ.MT. TOTAL COMM. AREA = 65.12 SQ.M.	04.45 / 25	04.45
<b>TOTAL CAR PARKING REQUIRED (COMM)</b>		
1 SCOOTER PARKING SPACE FOR EVERY 20.60 SQ.M.	10.03 / 20	10.03
TOTAL CAR PARKING REQ. 10 + 04.45	= 14.45 NOS.	
TOTAL CAR PARKING PROPOSED	= 20 NOS.	
4 LIVE PIT PUZZLE PARKING BELOW FLOOR LEVEL = 22 NOS.		
2 IN THE PUZZLE PARKING IN STREET = 05 NOS. TOTAL PARKING PROVIDED IN OPEN SPACE = 02 NOS.		
TOTAL SCOOTER PARKING REQ. (D) = 25 NOS.		
TOTAL SCOOTER PARKING PROPOSED = 30 NOS.		



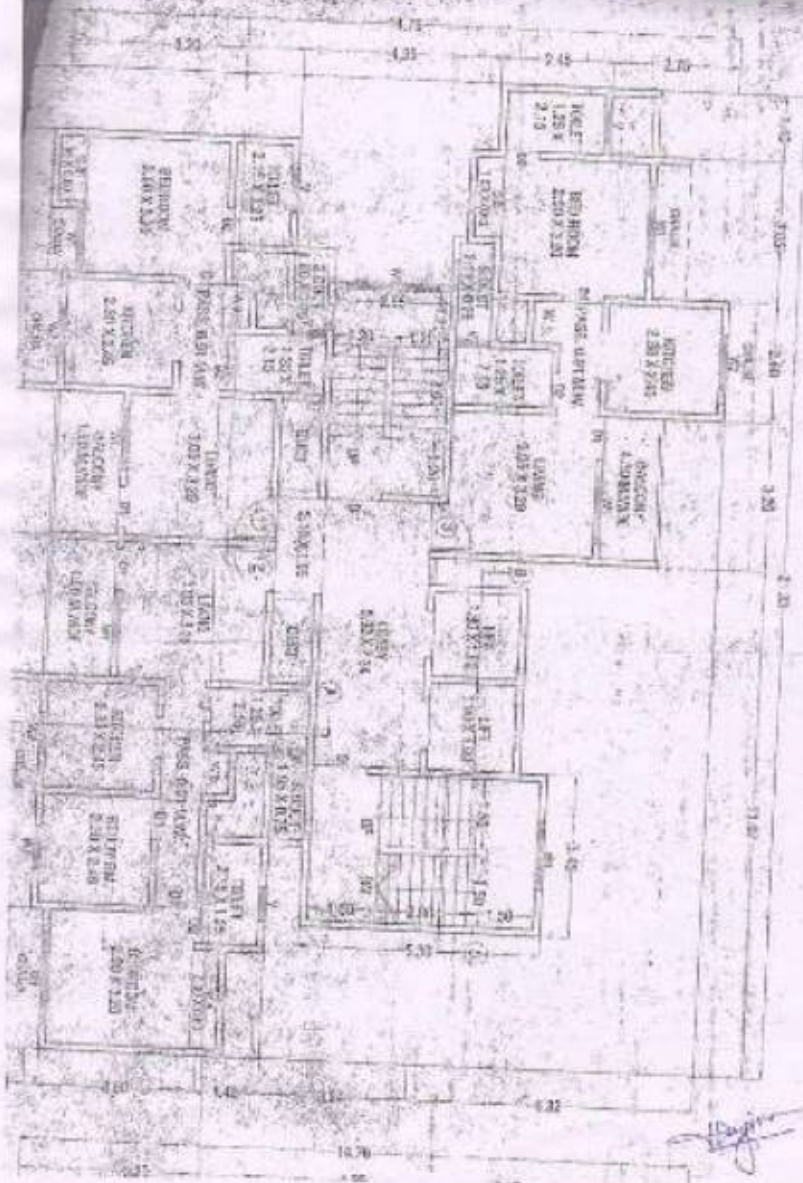

2.11 X 2.11 X 1

2.11 X 2.11 X 1	1.43	1.43
2.11 X 2.11 X 1	1.43	1.43
2.11 X 2.11 X 1	1.43	1.43

2.11 X 2.11 X 1	1.43	1.43
2.11 X 2.11 X 1	1.43	1.43
2.11 X 2.11 X 1	1.43	1.43

2.11 X 2.11 X 1


2.11 X 2.11 X 1	1.43	1.43
2.11 X 2.11 X 1	1.43	1.43
2.11 X 2.11 X 1	1.43	1.43

*Handwritten signature or initials.*

GROUND FLOOR NORTH PART





*Handwritten signature or initials in blue ink.*

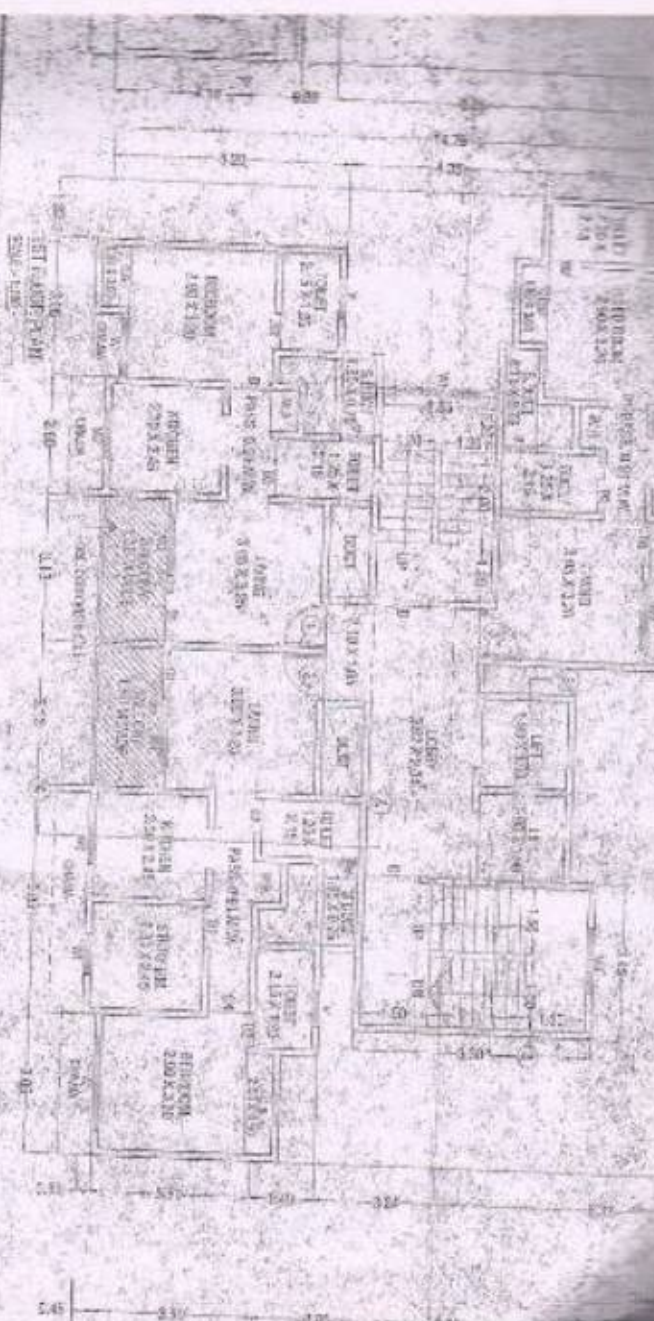

*[Handwritten signature]*





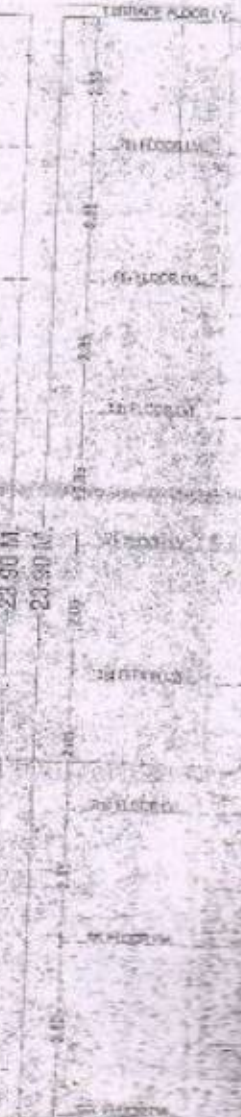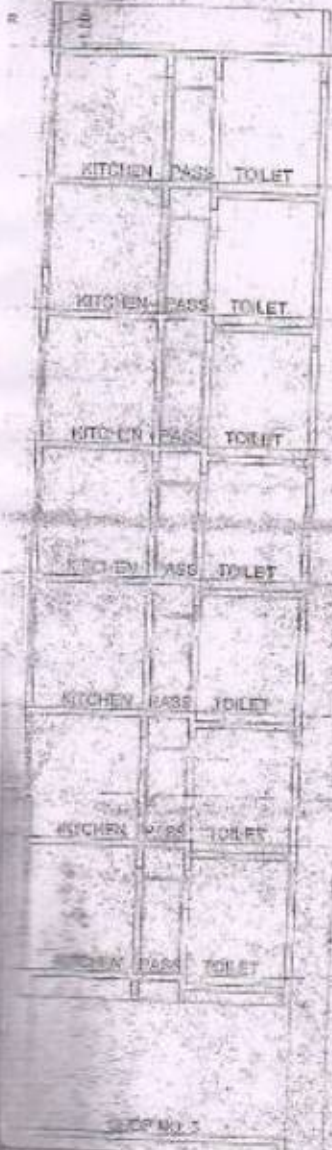


23.90 M  
23.90 M

SECTION A-A


*Handwritten signature*

SECTION  
Page 100

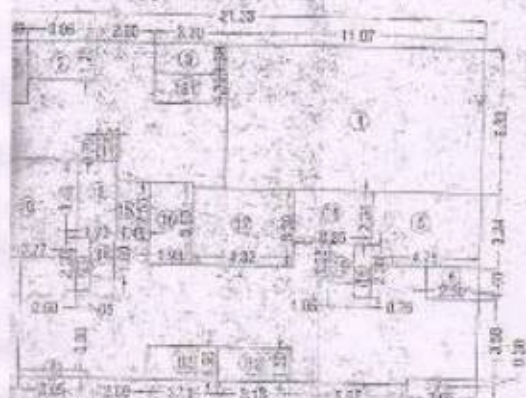

3-DIAGRAM OF TYPICAL FLOOR 2nd TO 8th FLOOR

Scale: 1:100

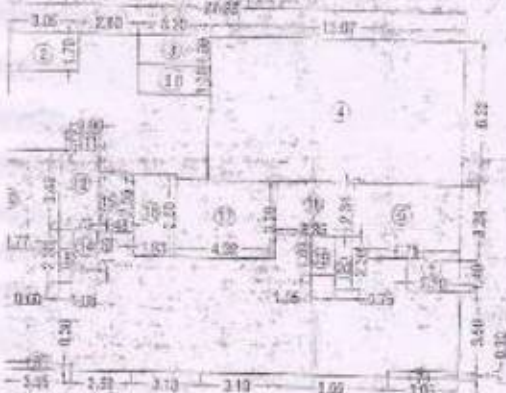

4-DIAGRAM OF TYPICAL FLOOR 9th TO 10th FLOOR


Scale: 1:100

FLOOR AREA CALCULATION (OFFICE PLAN)

NO.	ROOM NO.	AREA (sq. m)	NO.	ROOM NO.	AREA (sq. m)
1	1.01	2.76	11	1.11	1.50
2	2.01	4.70	12	1.12	1.50
3	3.01	1.20	13	1.13	1.50
4	4.01	3.20	14	1.14	1.50
5	5.01	3.84	15	1.15	1.50
6	6.01	1.90	16	1.16	1.50
7	7.01	0.30	17	1.17	1.50
8	8.01	0.30	18	1.18	1.50
9	9.01	1.20	19	1.19	1.50
10	10.01	4.55			
11	11.01	0.75			
12	12.01	5.45			
13	13.01	9.24			
14	14.01	1.50			
15	15.01	2.85			
16	16.01	3.80			
17	17.01	3.39			
18	18.01	2.24			
19	19.01	4.81			
20	20.01	3.20			
					175.32

AREA CALCULATION

NO.	ROOM NO.	AREA (sq. m)	NO.	ROOM NO.	AREA (sq. m)
01	1.01	1.20	1		4.75
02	1.12	1.20	2		0.35
					13.75
					184.53
					197.28
					12.24
					13.00
					0.70
					184.77

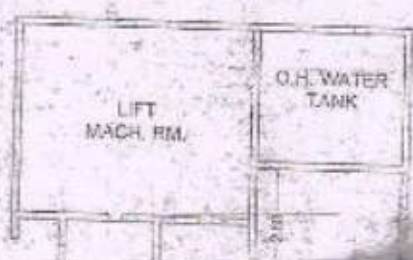

ROOF FLOOR PLAN