


BUILT-UP AREA DIAGRAM OF GROUND FLOOR
SCALE 1:200

BUILT-UP AREA CALCULATION - GROUND FLR.	
NO.	DESCRIPTION
1	4.80 X 9.20 X 1 = 42.32 SQM
2	4.97 X 7.80 X 1 = 38.77 SQM
3	4.51 X 1.80 X 1 = 5.86 SQM
4	5.80 X 7.90 X 1 = 39.53 SQM
TOTAL AREA = 126.48 SQM	




BUILT-UP AREA DIAGRAM OF BASEMENT FLOOR
SCALE 1:200

BUILT-UP AREA CALCULATION - BASEMENT FLR.	
NO.	DESCRIPTION
1	4.90 X 2.72 X 1 = 13.32 SQM
2	3.75 X 1.15 X 1 = 4.31 SQM
3	2.90 X 2.52 X 1 = 7.31 SQM
4	2.48 X 3.73 X 1 = 9.25 SQM
5	2.85 X 3.75 X 1 = 10.69 SQM
TOTAL AREA = 37.88 SQM	

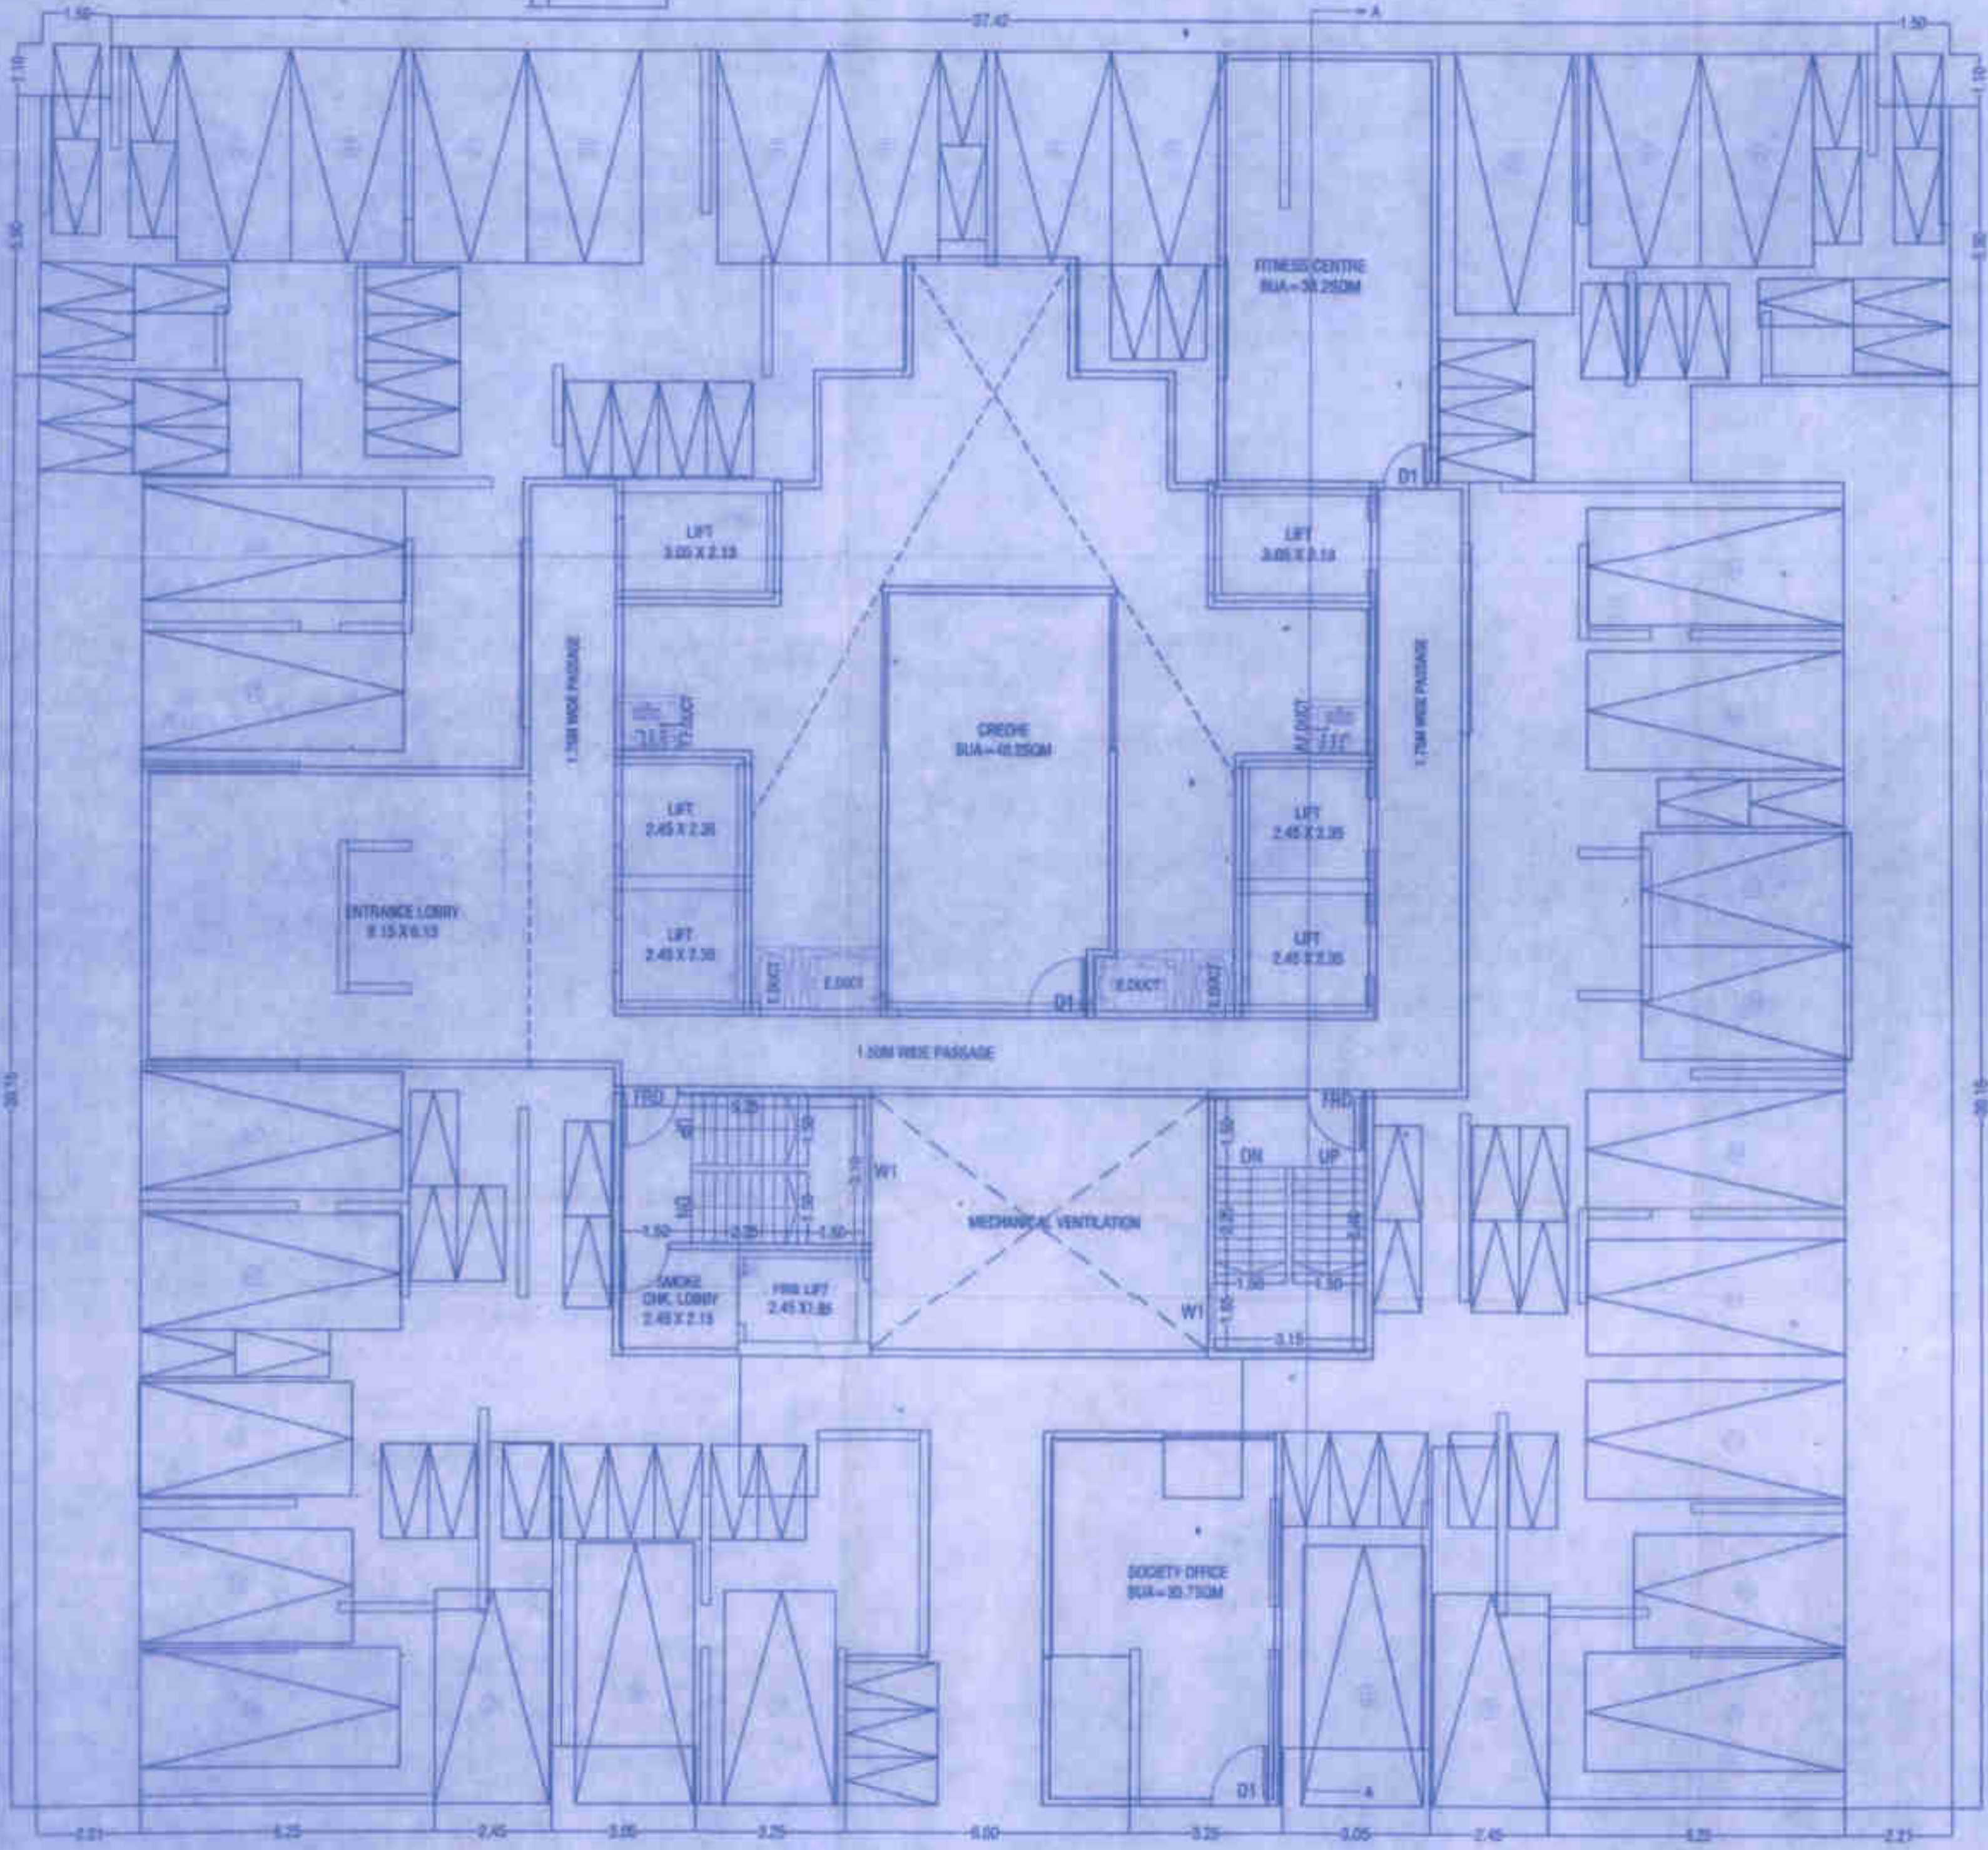

GROUND FLOOR PLAN
SCALE 1:100

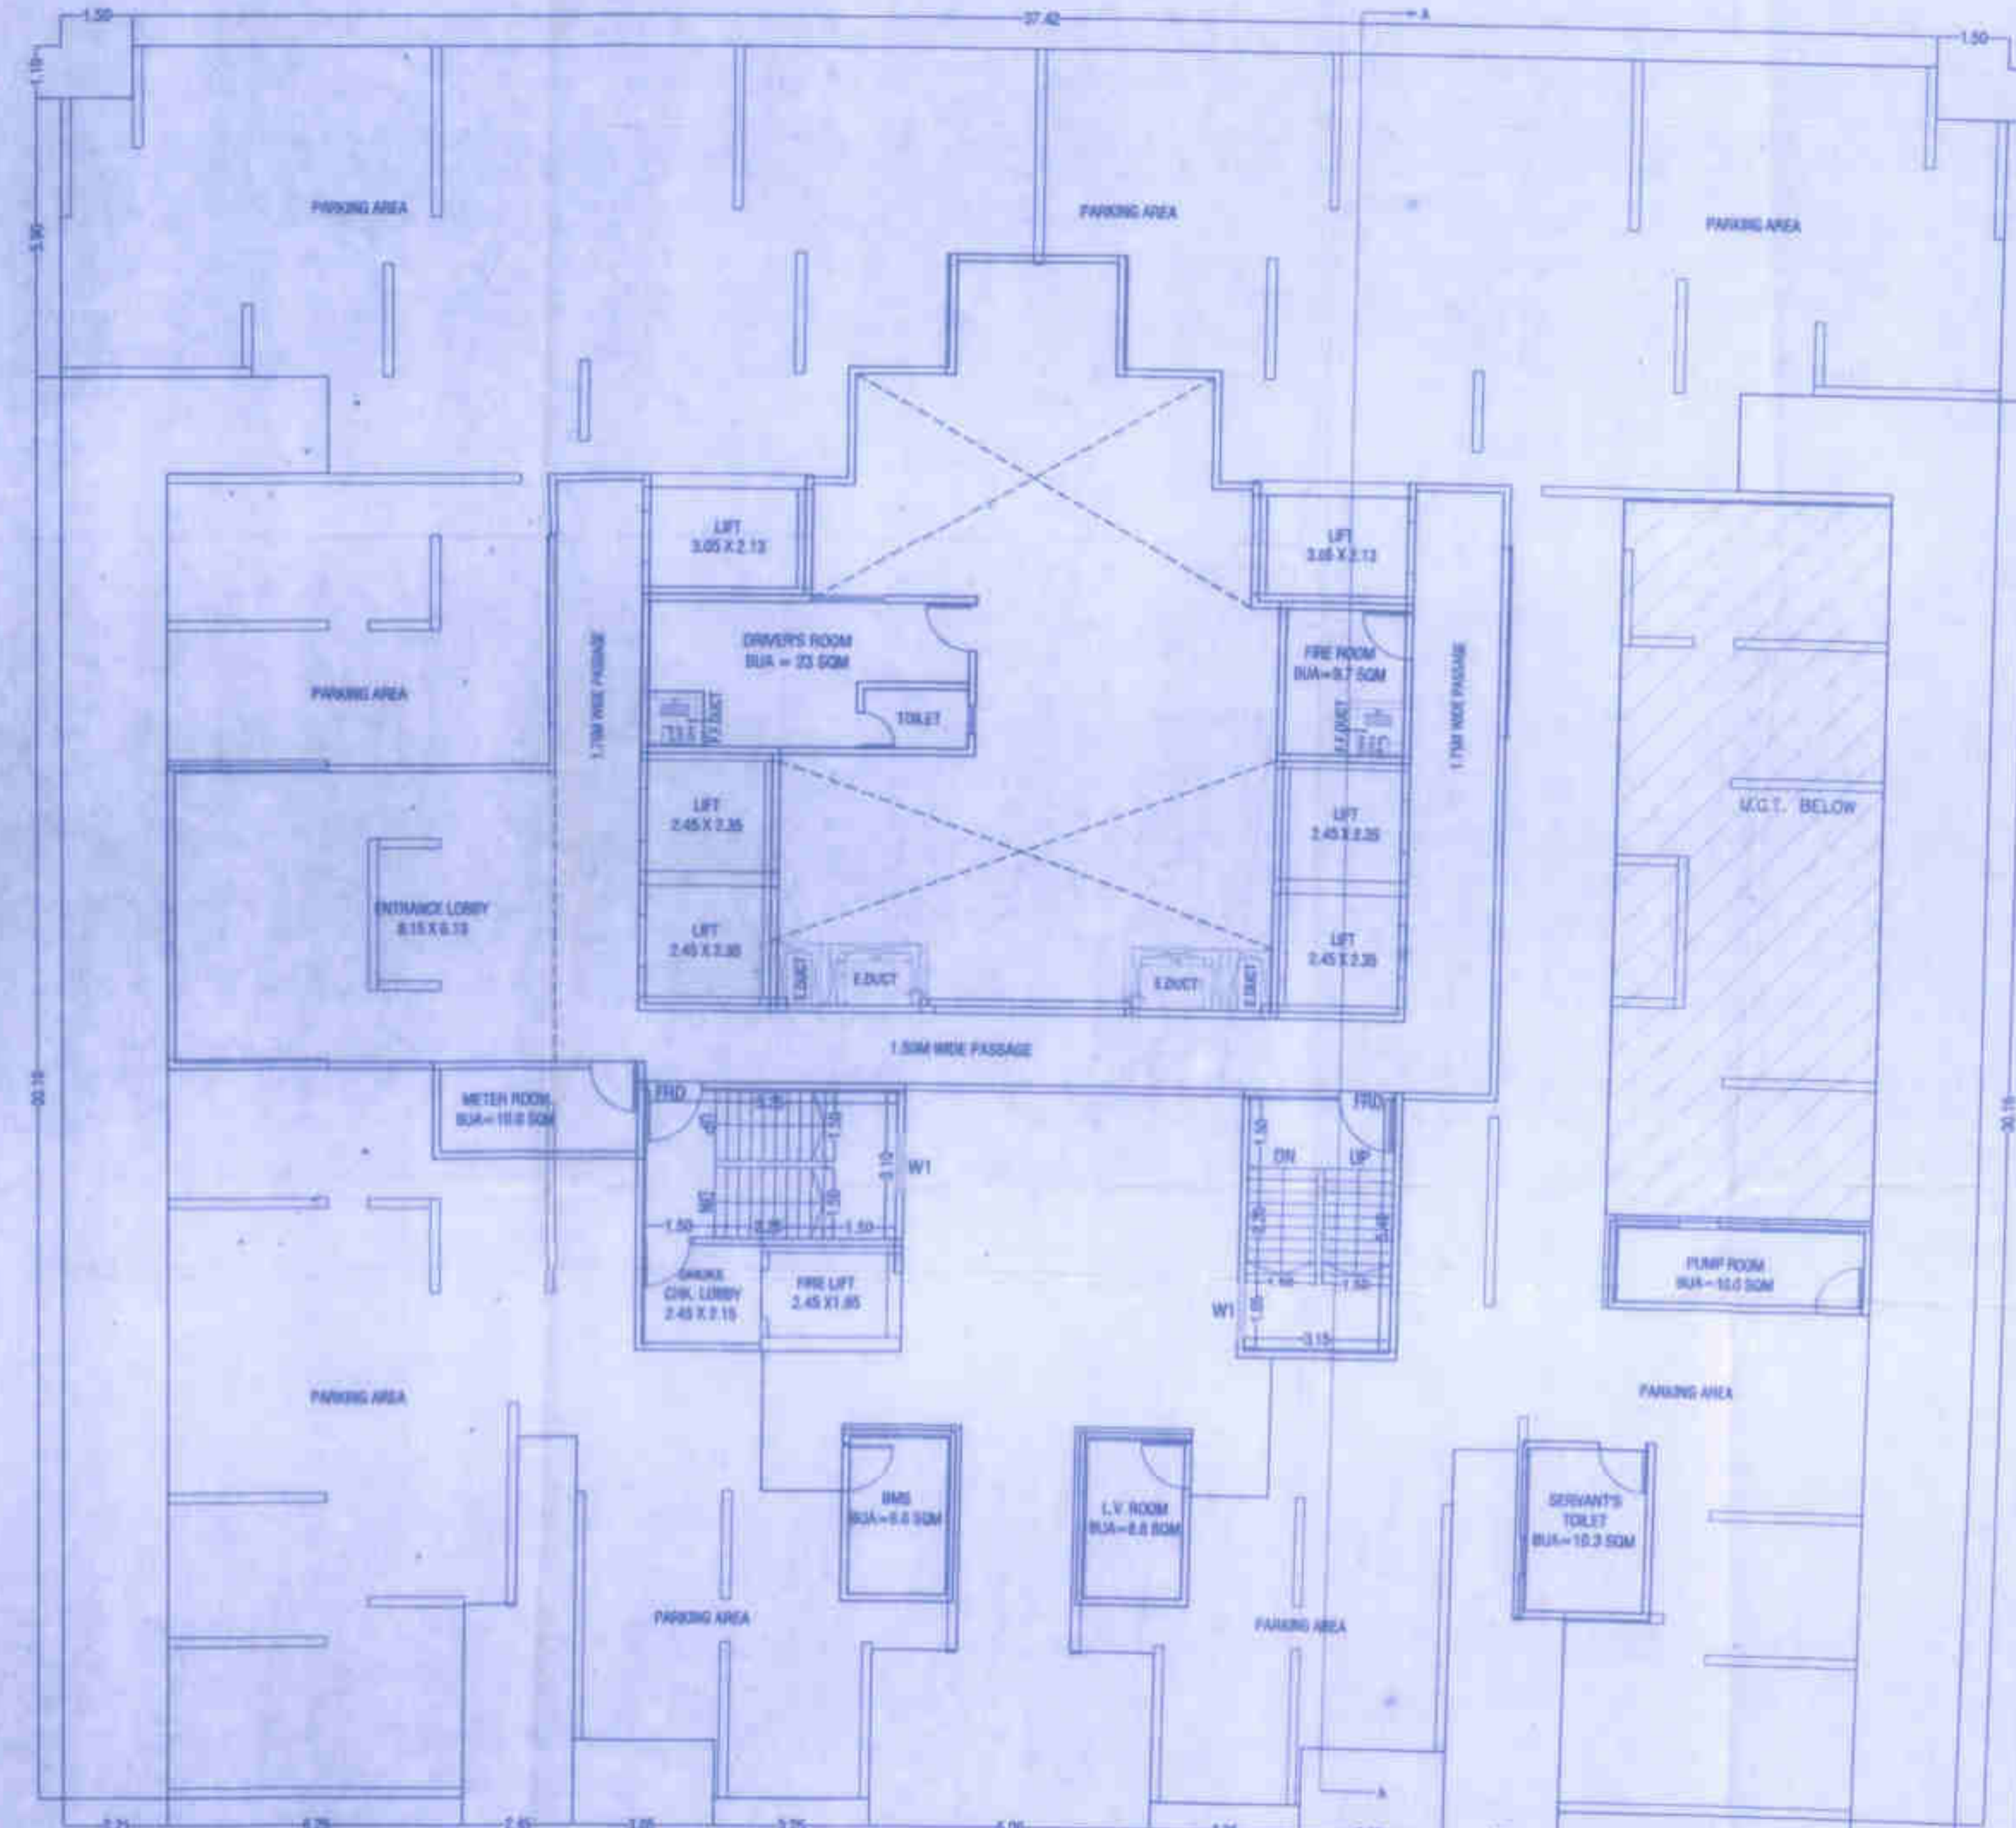

BASEMENT FLOOR PLAN
SCALE 1:100

PROPOSED BUILDINGS ON PLOT BEARING - S. NO.- 181/20, 181/21, 181/22, 156/3, AT VILLAGE - SHILL, TAL. DIST. - THANE
STAMP OF APPROVAL OF PLAN

Thane Municipal Corporation
The City of Thane
Deputy Engineer (TDD)
Executive Engineer (TDD)



CERTIFICATE OF AREA
CERTIFIED THAT THE PLOT UNDER REFERENCE WAS SURVEYED BY ME ON ... AND THE DIMENSIONS OF SIDES, ETC. OF PLOT STATED ON PLAN ARE AS MEASURED ON SITE AND THE AREA SO WORKED OUT TALLIES WITH THE AREA STATED IN DOCUMENTS IMMEDIATELY.

OWNER'S DECLARATION
OWNER (S) name and signature
Architect/ Licensed Engineer/Supervisor name and signature
Job No. Drawing No. Scale Drawn by/ Checked by/ Registration No. of Architect/ License no. of Licensed Engineer/ Supervisor

ARCHITECT
10 FOLDS
ARCHITECTS & CONSULTANTS
305, A Wing, Dev Corpers, Eastern Express Highway, Colaba Junction, Khar, Thane (W) 400 001.
T: 022-4108862 / 83 / 84, Email: 10foldsarchitects@gmail.com

